



4 TYPICAL EXTERIOR FOUNDATION AT WALK-OUT LEVEL
S2.01 SCALE : 3/4" = 1'-0"

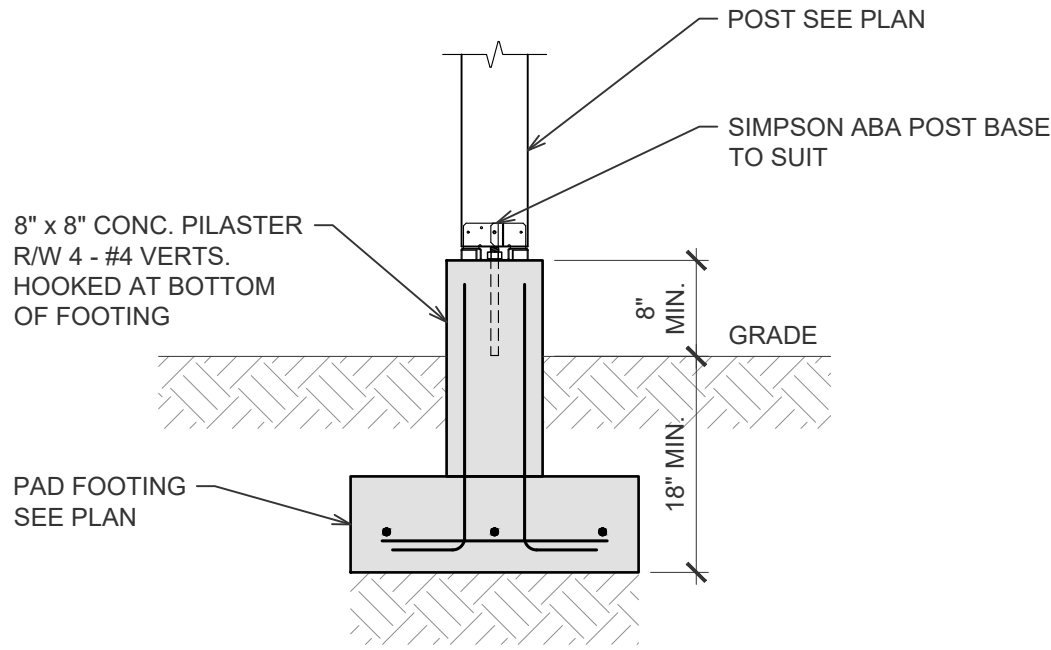

5 TYPICAL EXTERIOR POST DETAIL
S2.01 SCALE : 3/4" = 1'-0"

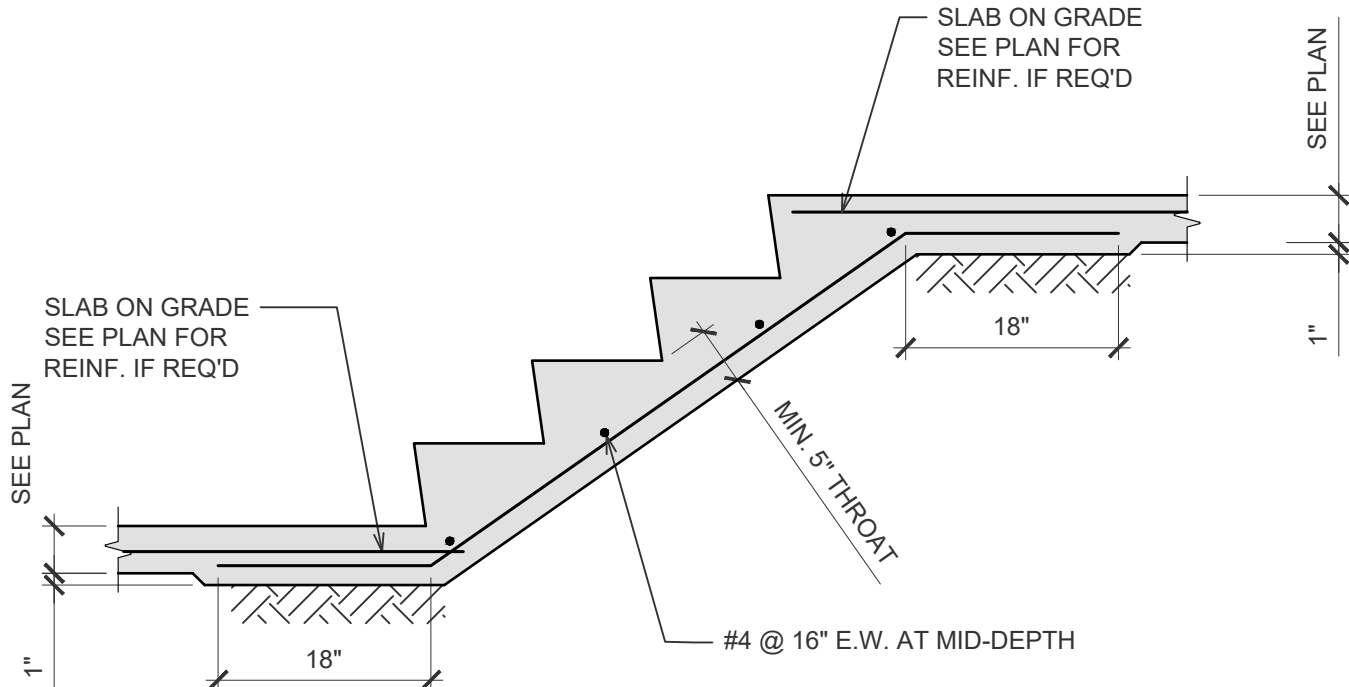

6 TYPICAL STAIRS ON GRADE
S2.01 SCALE : 3/4" = 1'-0"

PAD FOOTING SCHEDULE		
TYPE	SIZE	REINFORCING
PF1	2'-6" x 2'-6" x 10" DP.	3 - #4 L.W. BOT., 3 - #4 S.W. BOT.

CONCRETE PILASTER SCHEDULE		
TYPE	SIZE	REINFORCING
CP1	8" x 8"	4 - #4 VERTS.


DECKING SCHEDULE	
TYPE	SIZE
D1	EXISTING PLYWOOD SHEATHING
D2	EXISTING 2x12 DECKING
D3	NEW 2x12 DECKING TO MATCH EXISTING

BEAM SCHEDULE		
TYPE	SIZE	NOTES
B1	2 x 6	
B2	2 x 8	
B3	2 x 10	
B4	2 x 12	
B5	1 3/4" x 9 1/2" LVL	
B6	1 3/4" x 11 7/8" LVL	


NOTE: ALL BEAMS TO BE MINIMUM 2B3 (2-PLY 2x10) DROP BEAMS UNLESS NOTED OTHERWISE. SOLID BEAMS (PSL) SHALL NOT BE SUBSTITUTED WITH LAMINATED BEAMS (LVL) UNLESS APPROVED BY SKYLINE.

JOIST SCHEDULE		
TYPE	SIZE	NOTES
J1	2 x 6	SEE PLAN
J2	2 x 8	SEE PLAN
J3	2 x 10	SEE PLAN
J4	2 x 12	SEE PLAN
J5	9 1/2" DP. TJI	
J6	11 1/8" DP. TJI	


POST SCHEDULE	
TYPE	SIZE
P1	2 x 4
P2	2 x 6
P3	2 x 8
P4	4 x 4
P5	6 x 6

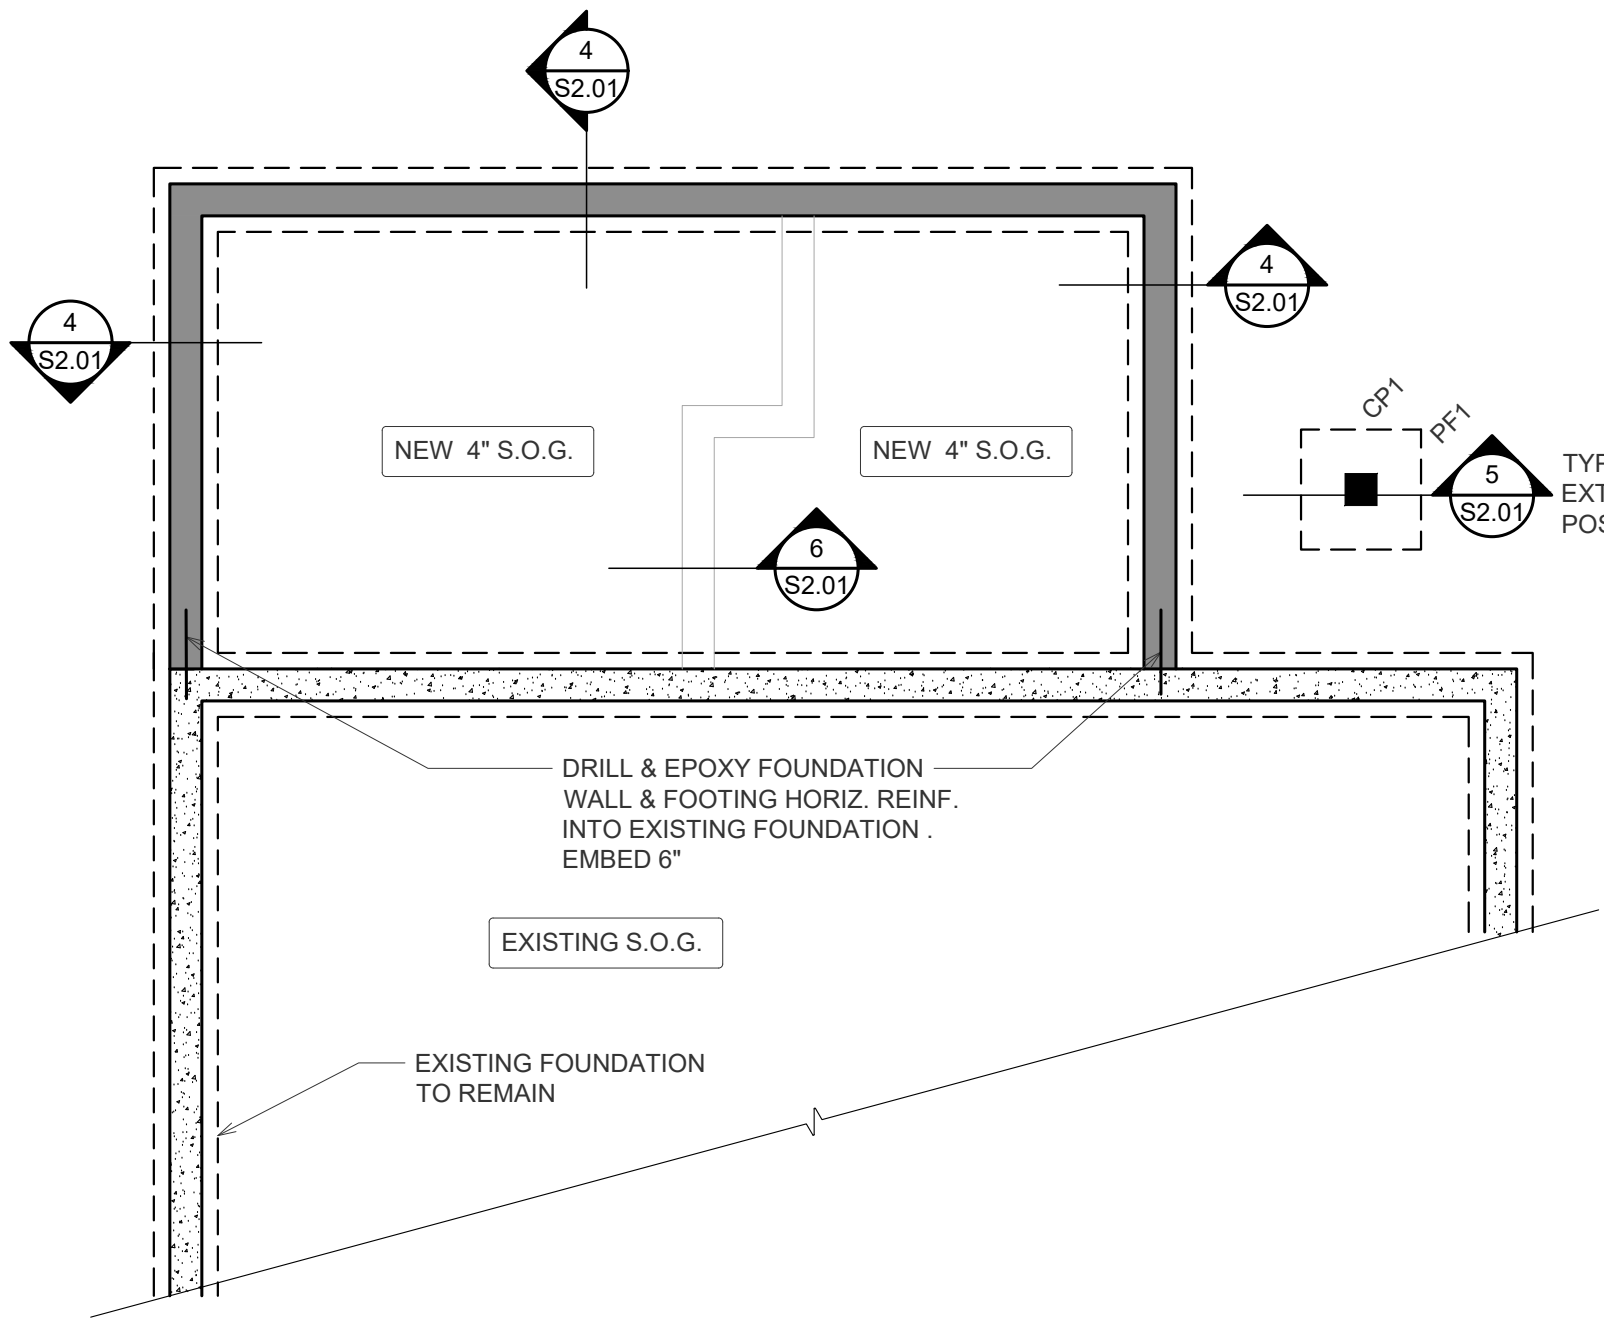


1 FOUNDATION PLAN
S2.01 SCALE : 1/4" = 1'-0"

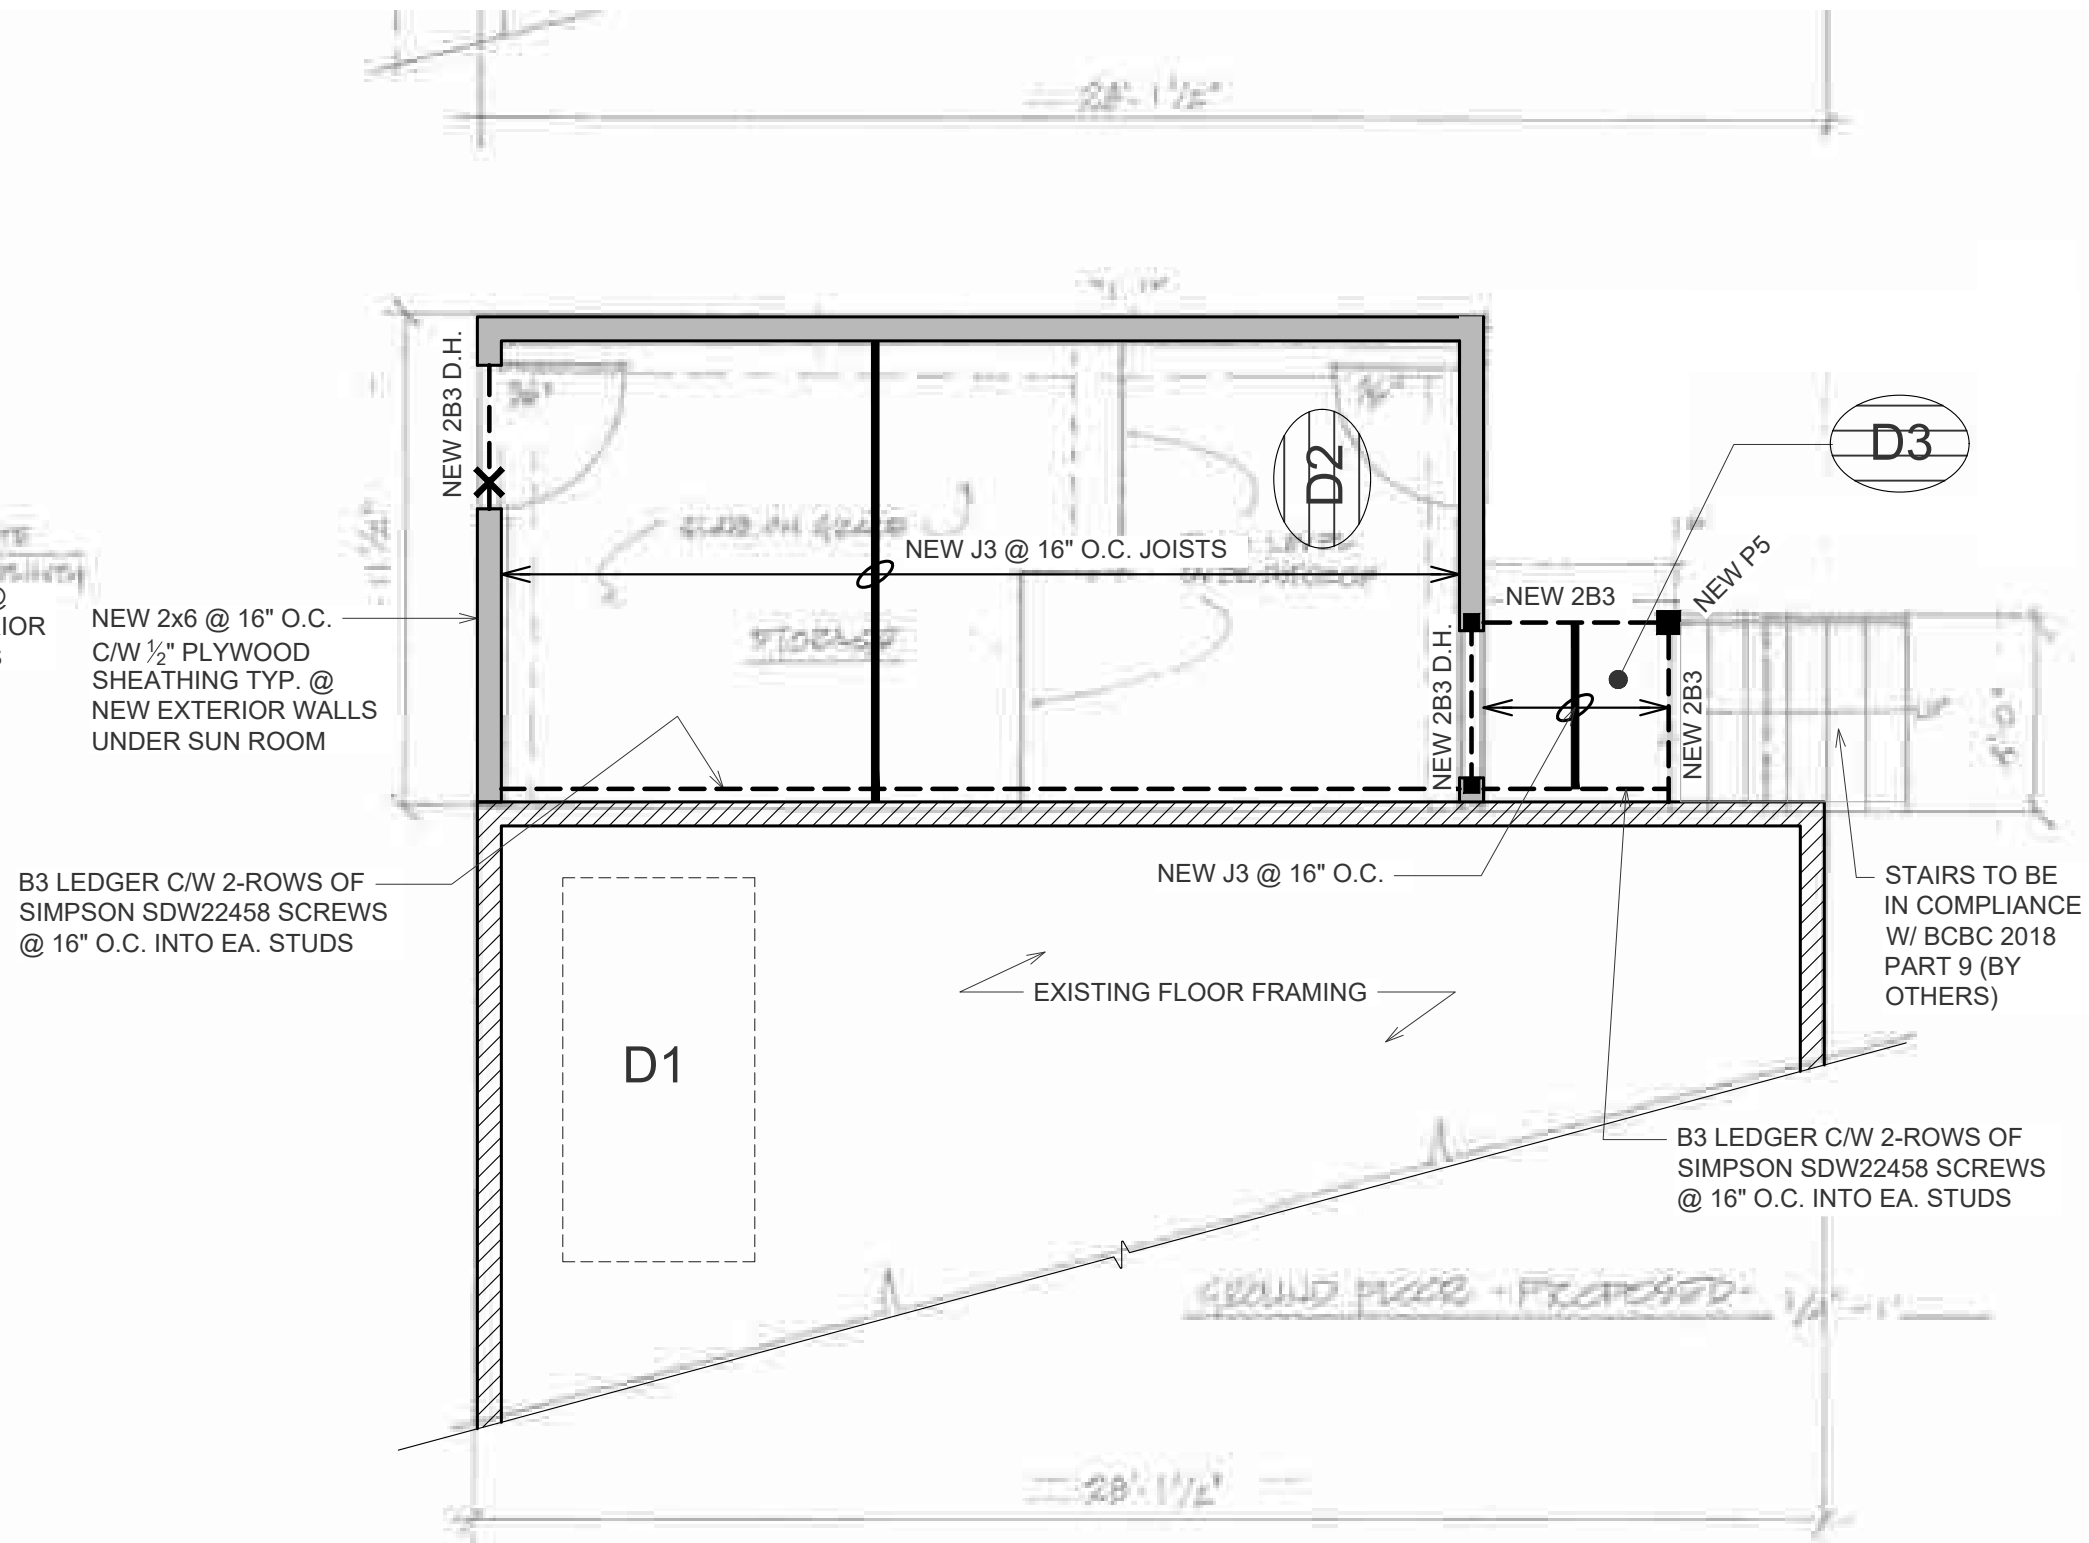

2 GROUND FLOOR PLAN W/ MAIN FL. FRAMING OVER
S2.01 SCALE : 1/4" = 1'-0"

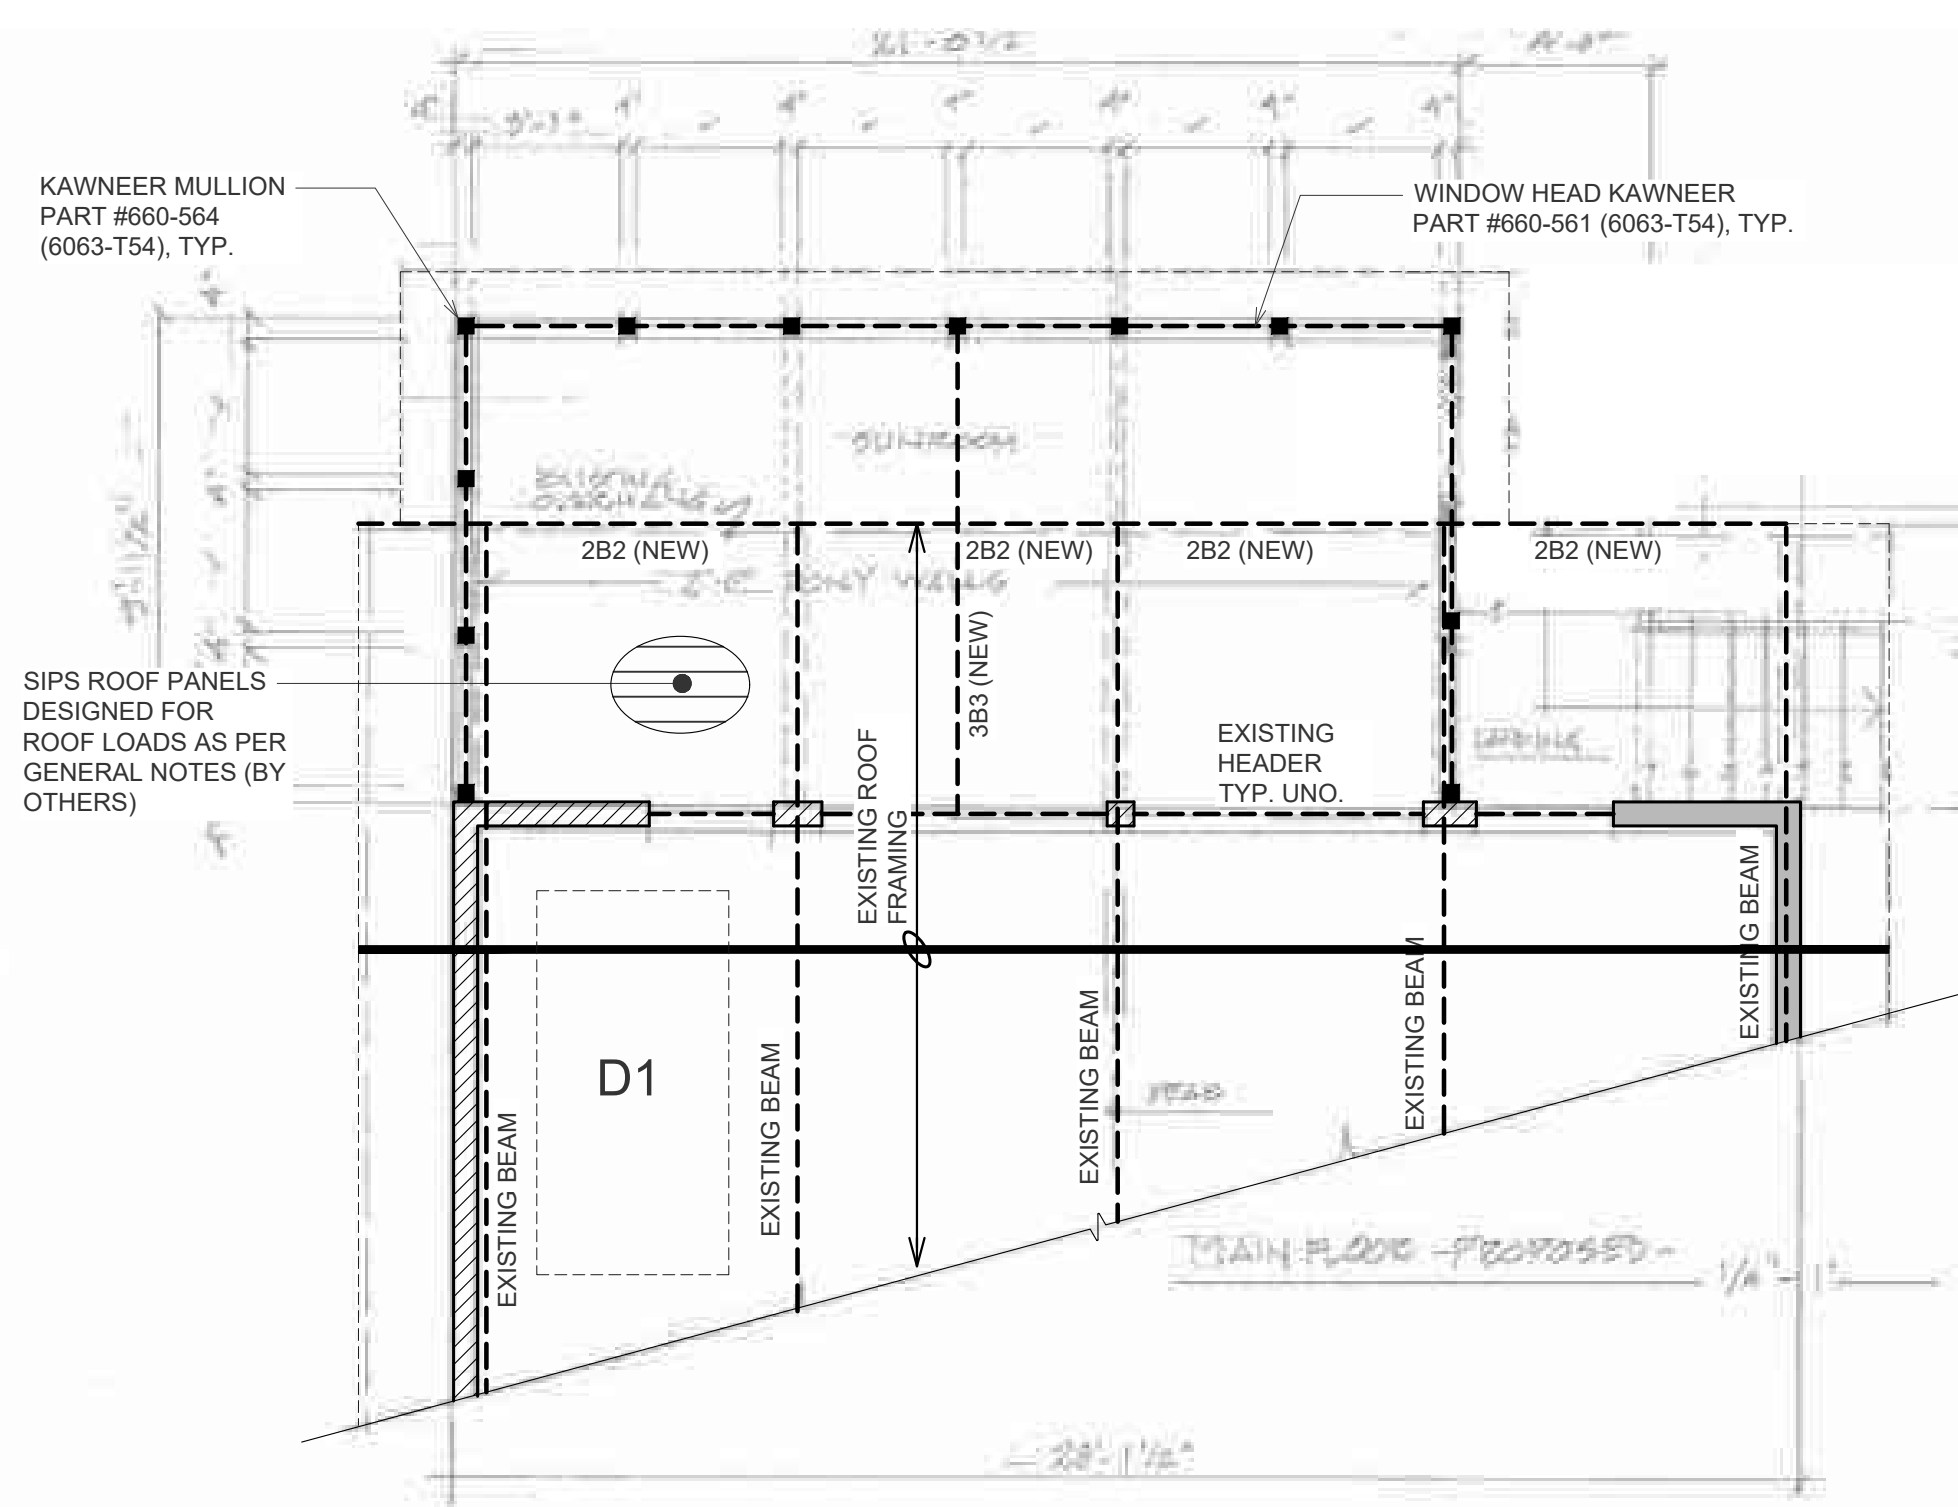

3 MAIN FLOOR PLAN W/ ROOF FRAMING OVER
S2.01 SCALE : 1/4" = 1'-0"




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3	2022 04 13	REVISIONS
2	2022 03 22	REVISIONS
1	2020 06 16	ISSUED FOR BUILDING PERMIT
NO	DATE	REVISION

SEAL:

SKYLINE ENGINEERING LTD.
PERMIT TO PRACTICE
NO. 1001306

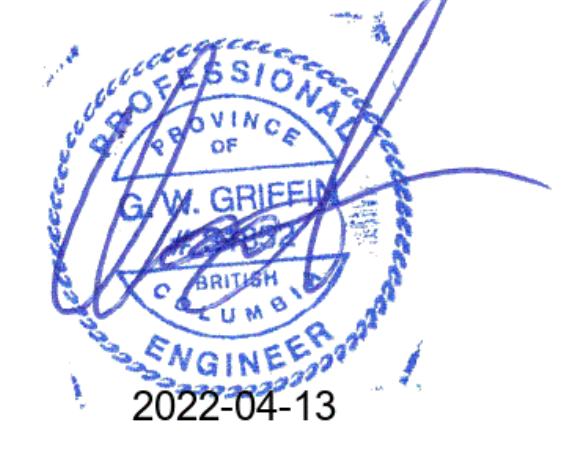

2022-04-13

PROJECT NAME:

2109 SARITA ROAD

SHEET TITLE:

FLOOR PLANS
SECTIONS

PROJECT NO:

10347.12

SCALE:

AS NOTED

DRAWN:

M.E.

E.O.R.:

W.G.

DRAWING NO:

S2.01